
RESIDENCE

KITCHEN / GREAT ROOM INTERIOR REMODEL

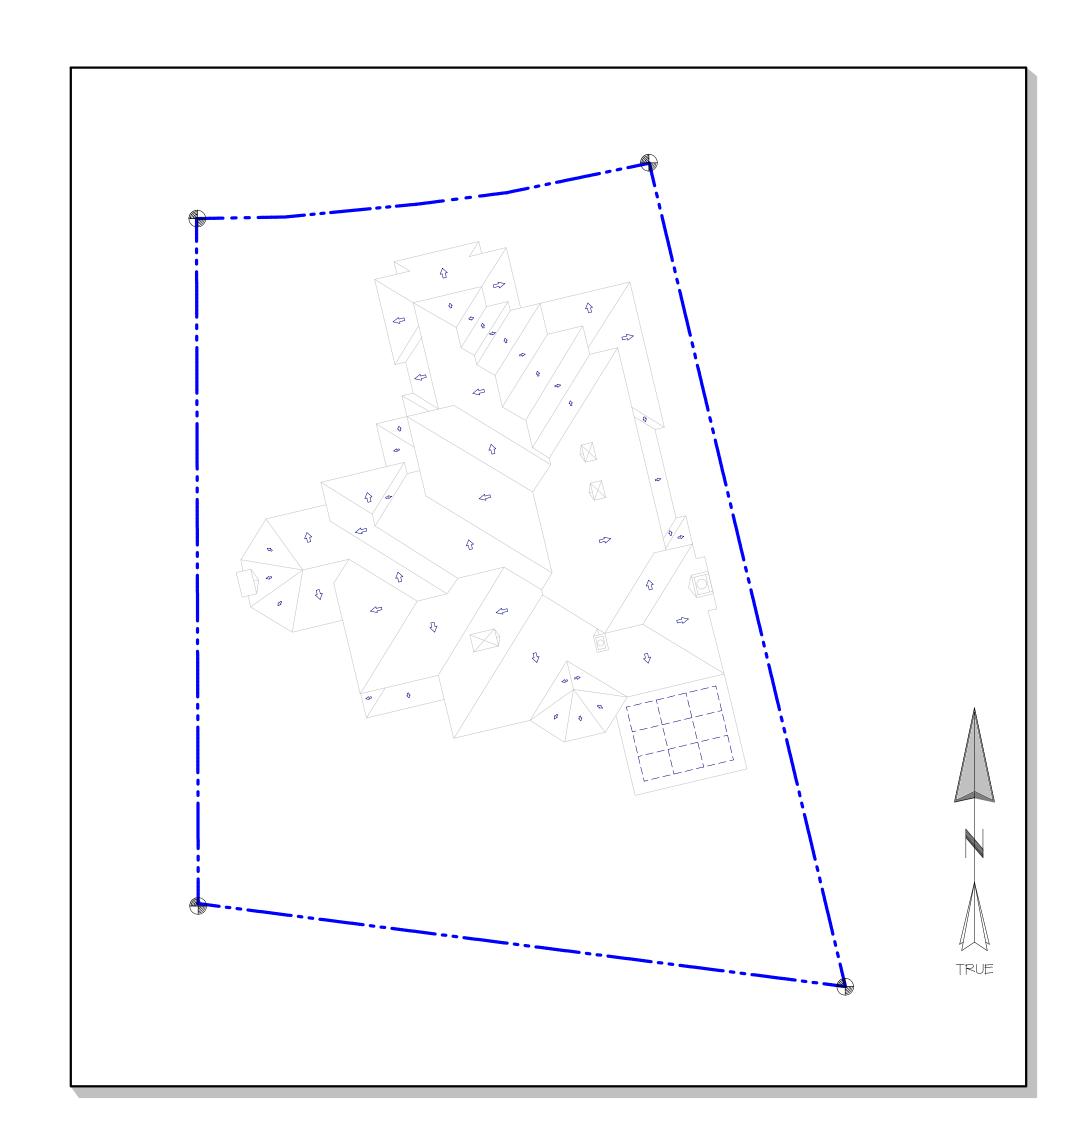

Site / Roof Plan

1/16"= 1'-0"

BUILDING FLOOR AREAS

LIVABLE SPACE BLDG LEVEL EXISTING FT² NEW FT² TOTAL FT² • Main 2,525 & 2,525 • Upper 2,381 & 2,381 • TOTAL (Livable) 4,906 ×

NON-LIVABLE SPACE

• TOTAL

DECSRIPTION	EXISTING FT ²	NEW FT ²	TOTAL FT
GarageDecks / Accessory	1,060 342	X X	1, <i>060</i> 342
• TOTAL (Non-Livable)	1,402	<u> </u>	1,402
TOTAL SPACE			
DECSRIPTION	EXISTING FT2	NEW FT ²	TOTAL FT


PROJECT SCOPE OF WORK

6,3*0*8

6,3*0*8

- 1) Demo Existing Interior Stud Walls (Shearwall) in Kitchen and Exterior Door and Shearwalls on Main Level
- 2) New Footings and In-Fill Floor Slab on Main Level
- 3) Reframe Interior Shearwall and Add Exterior Moment Frame
- 4) Construct (N) Floor Beam Above Great Room
- 5) Construct (N) Kitchen Cabs, Counters, and Appiliances

Provide Asbestos Testing of Existing
Architectural Finishes and Cavity Fillers
Prior to Full Demolistion of Affected Areas.

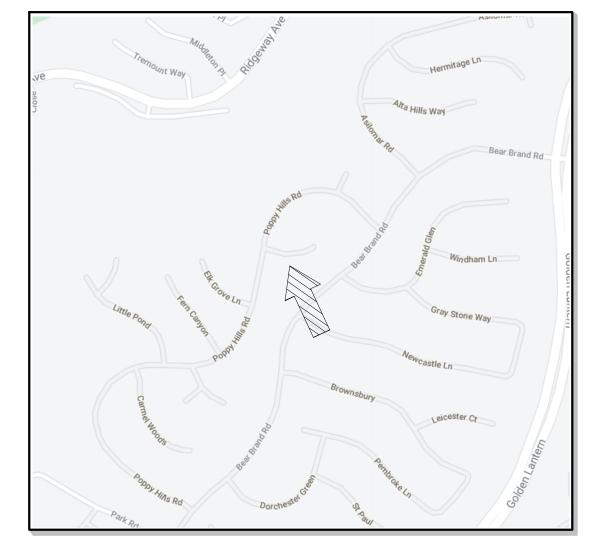

VICINITY MAP

No Scale

PROPERTY LEGAL DESCRIPTION



- Construction Type: V-B
- Occupancy Classification: R-3
- HOA: Ocean Ranch at Bear Brand

PROJECT CONSULTANT

Architectural: BLUE WATER Engineering Corp.
 \$ Structural:


CODES & COMPLIANCE

- BUILDING: 2019 California Building Code (CBC)
- ELECTRICAL: 2019 California Electrical Code (CEC)
- PLUMBING: 2019 California Plumbing Code (CPC)
- ENERGY: 2019 California Building Energy Efficiency Standards

PROJECT TABLE OF CONTENTS: SUBMITTALS & REVISIONS						
Sheet No.	Sheet Title	A	В			
Τ1	Project Title Sheet	1				
A1.1	As-Built Plan: First Level	1	√			
A1.2	As-Built Plan: 2nd Level	/	/			
A2 ₋ 1	Proposed Interior Remodel Plan	1	1			
A2.2	South Elevation: As-Built & Proposed	1	1			
E1.1	Proposed Electrical Plan		/			
SN1.1	Structural Notes and Material Specifications	1	1			
SN1.2	Structural Notes and Material Specifications	1	1			
51.1	Structural Foundation Plan	1	✓			
52 ₋ 1	Structural Floor Framing Plan	/	/			
SD2.1	Structural Details - Foundation	/	1			
SD2.2	Structural Details - Framing	/	/			
SD2.3	Structural Details - Framing	/	1			

INTERIOR REMODEL


SENGINEERING CORP.——

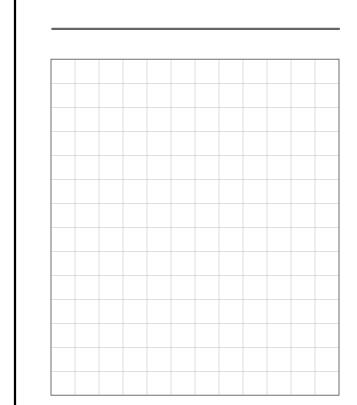

MK	DATE	DESCRIPTION
А	1/12/22	Building Dept Submittal
В	4/05/22	Plan Check Corrections

REGISTRATION AND SIGNATURE


BLUE WATER Project Number 21032
Designer SAB
Engineer ROZ

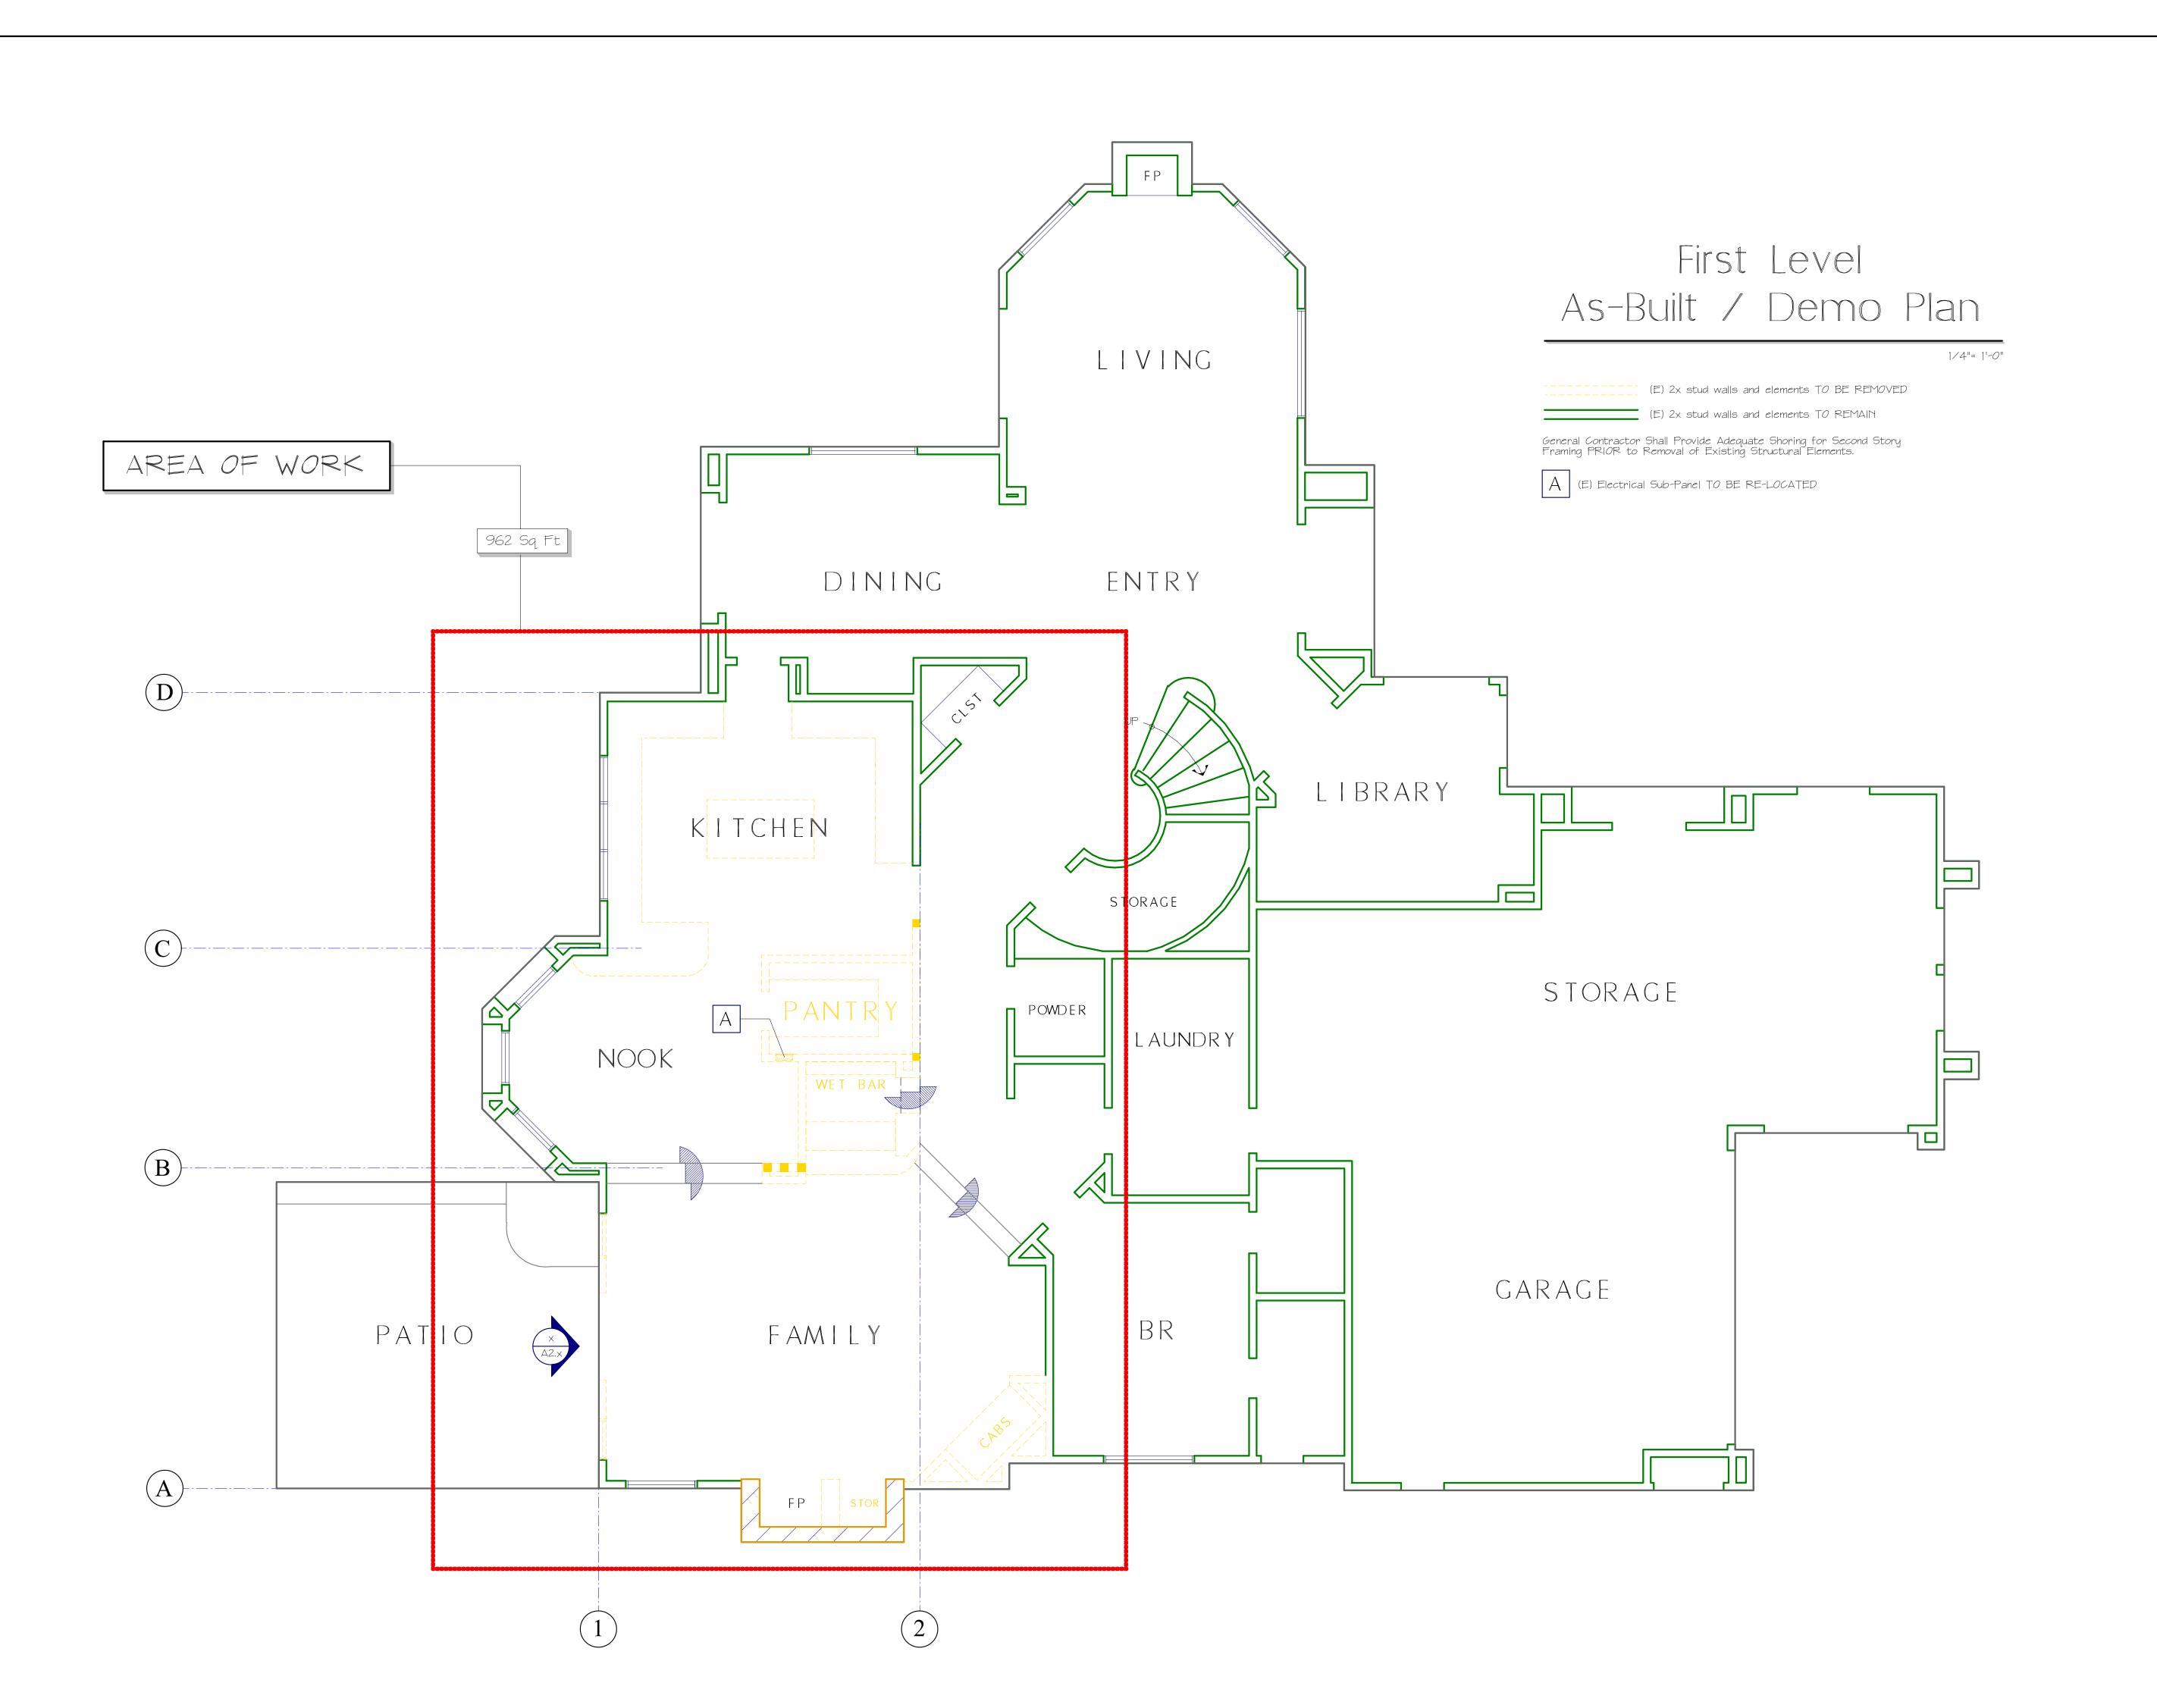

LCL WALL TO K

- ENGINEERING CORP.


Consulting Structural Engineering & Design

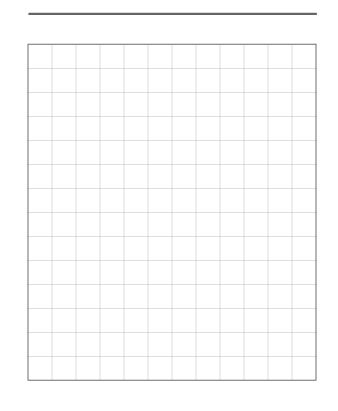

DRAI	JING ISSI	UES AND REVISIONS	
MK	DATE	DESCRIPTION	E
A	1/12/22	Building Dept Submittal	R
В	4/05/22	Plan Check Corrections	R


REGISTRATION AND SIGNATURE	

BLUE WATER Project Number	21032
Designer	SAB
Engineer	ROZ
Scale	as noted

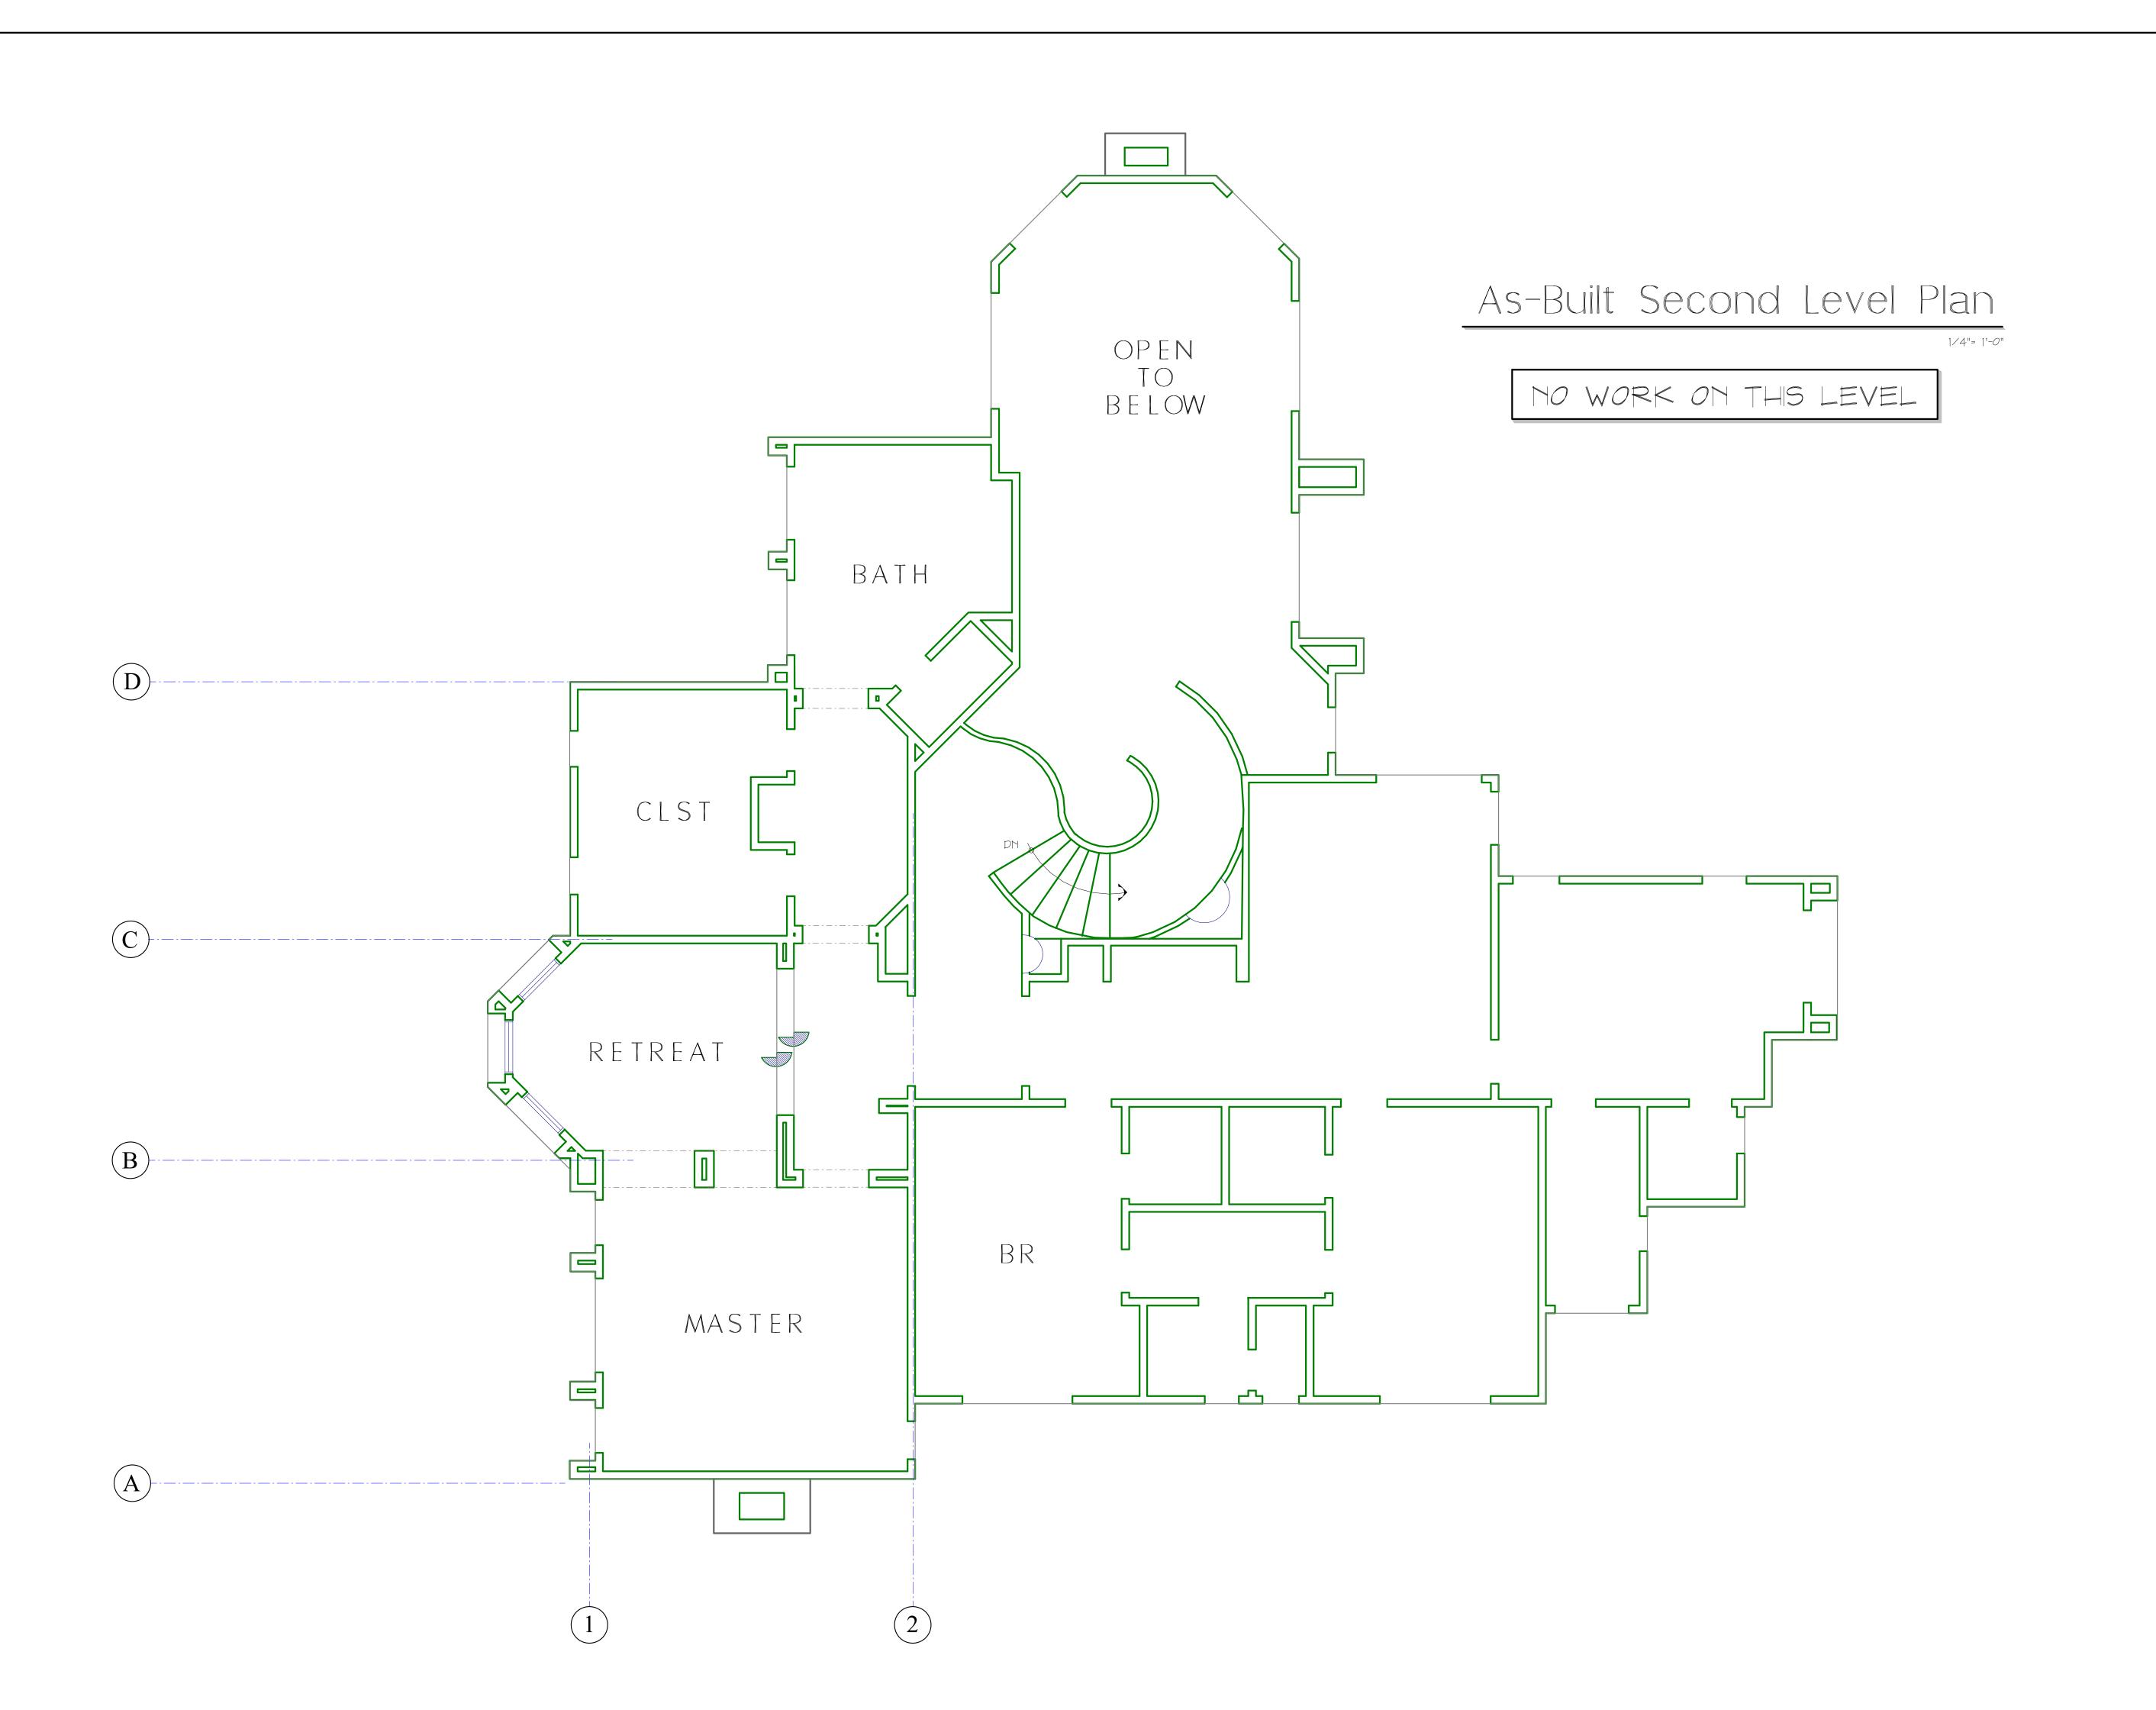

BLUE WATER


--- ENGINEERING CORP. ---

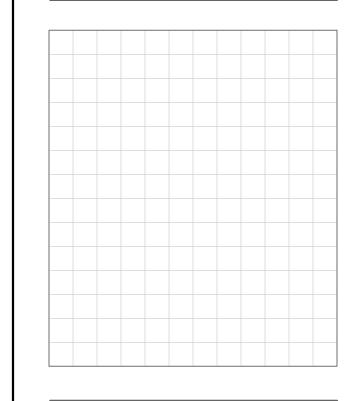


MK DAT	re	DE	SCRIPTIC	MC
A 1/12/	/22	Buildin	g Dept Sub	mittal
B 4/05	/22	Plan C	heck Corre	ctions

REGISTRATION AND SIGNATURE

BLUE WATER Project Number	21 <i>0</i> 32
Designer	SAB
Engineer	R0Z
Scale	as noted

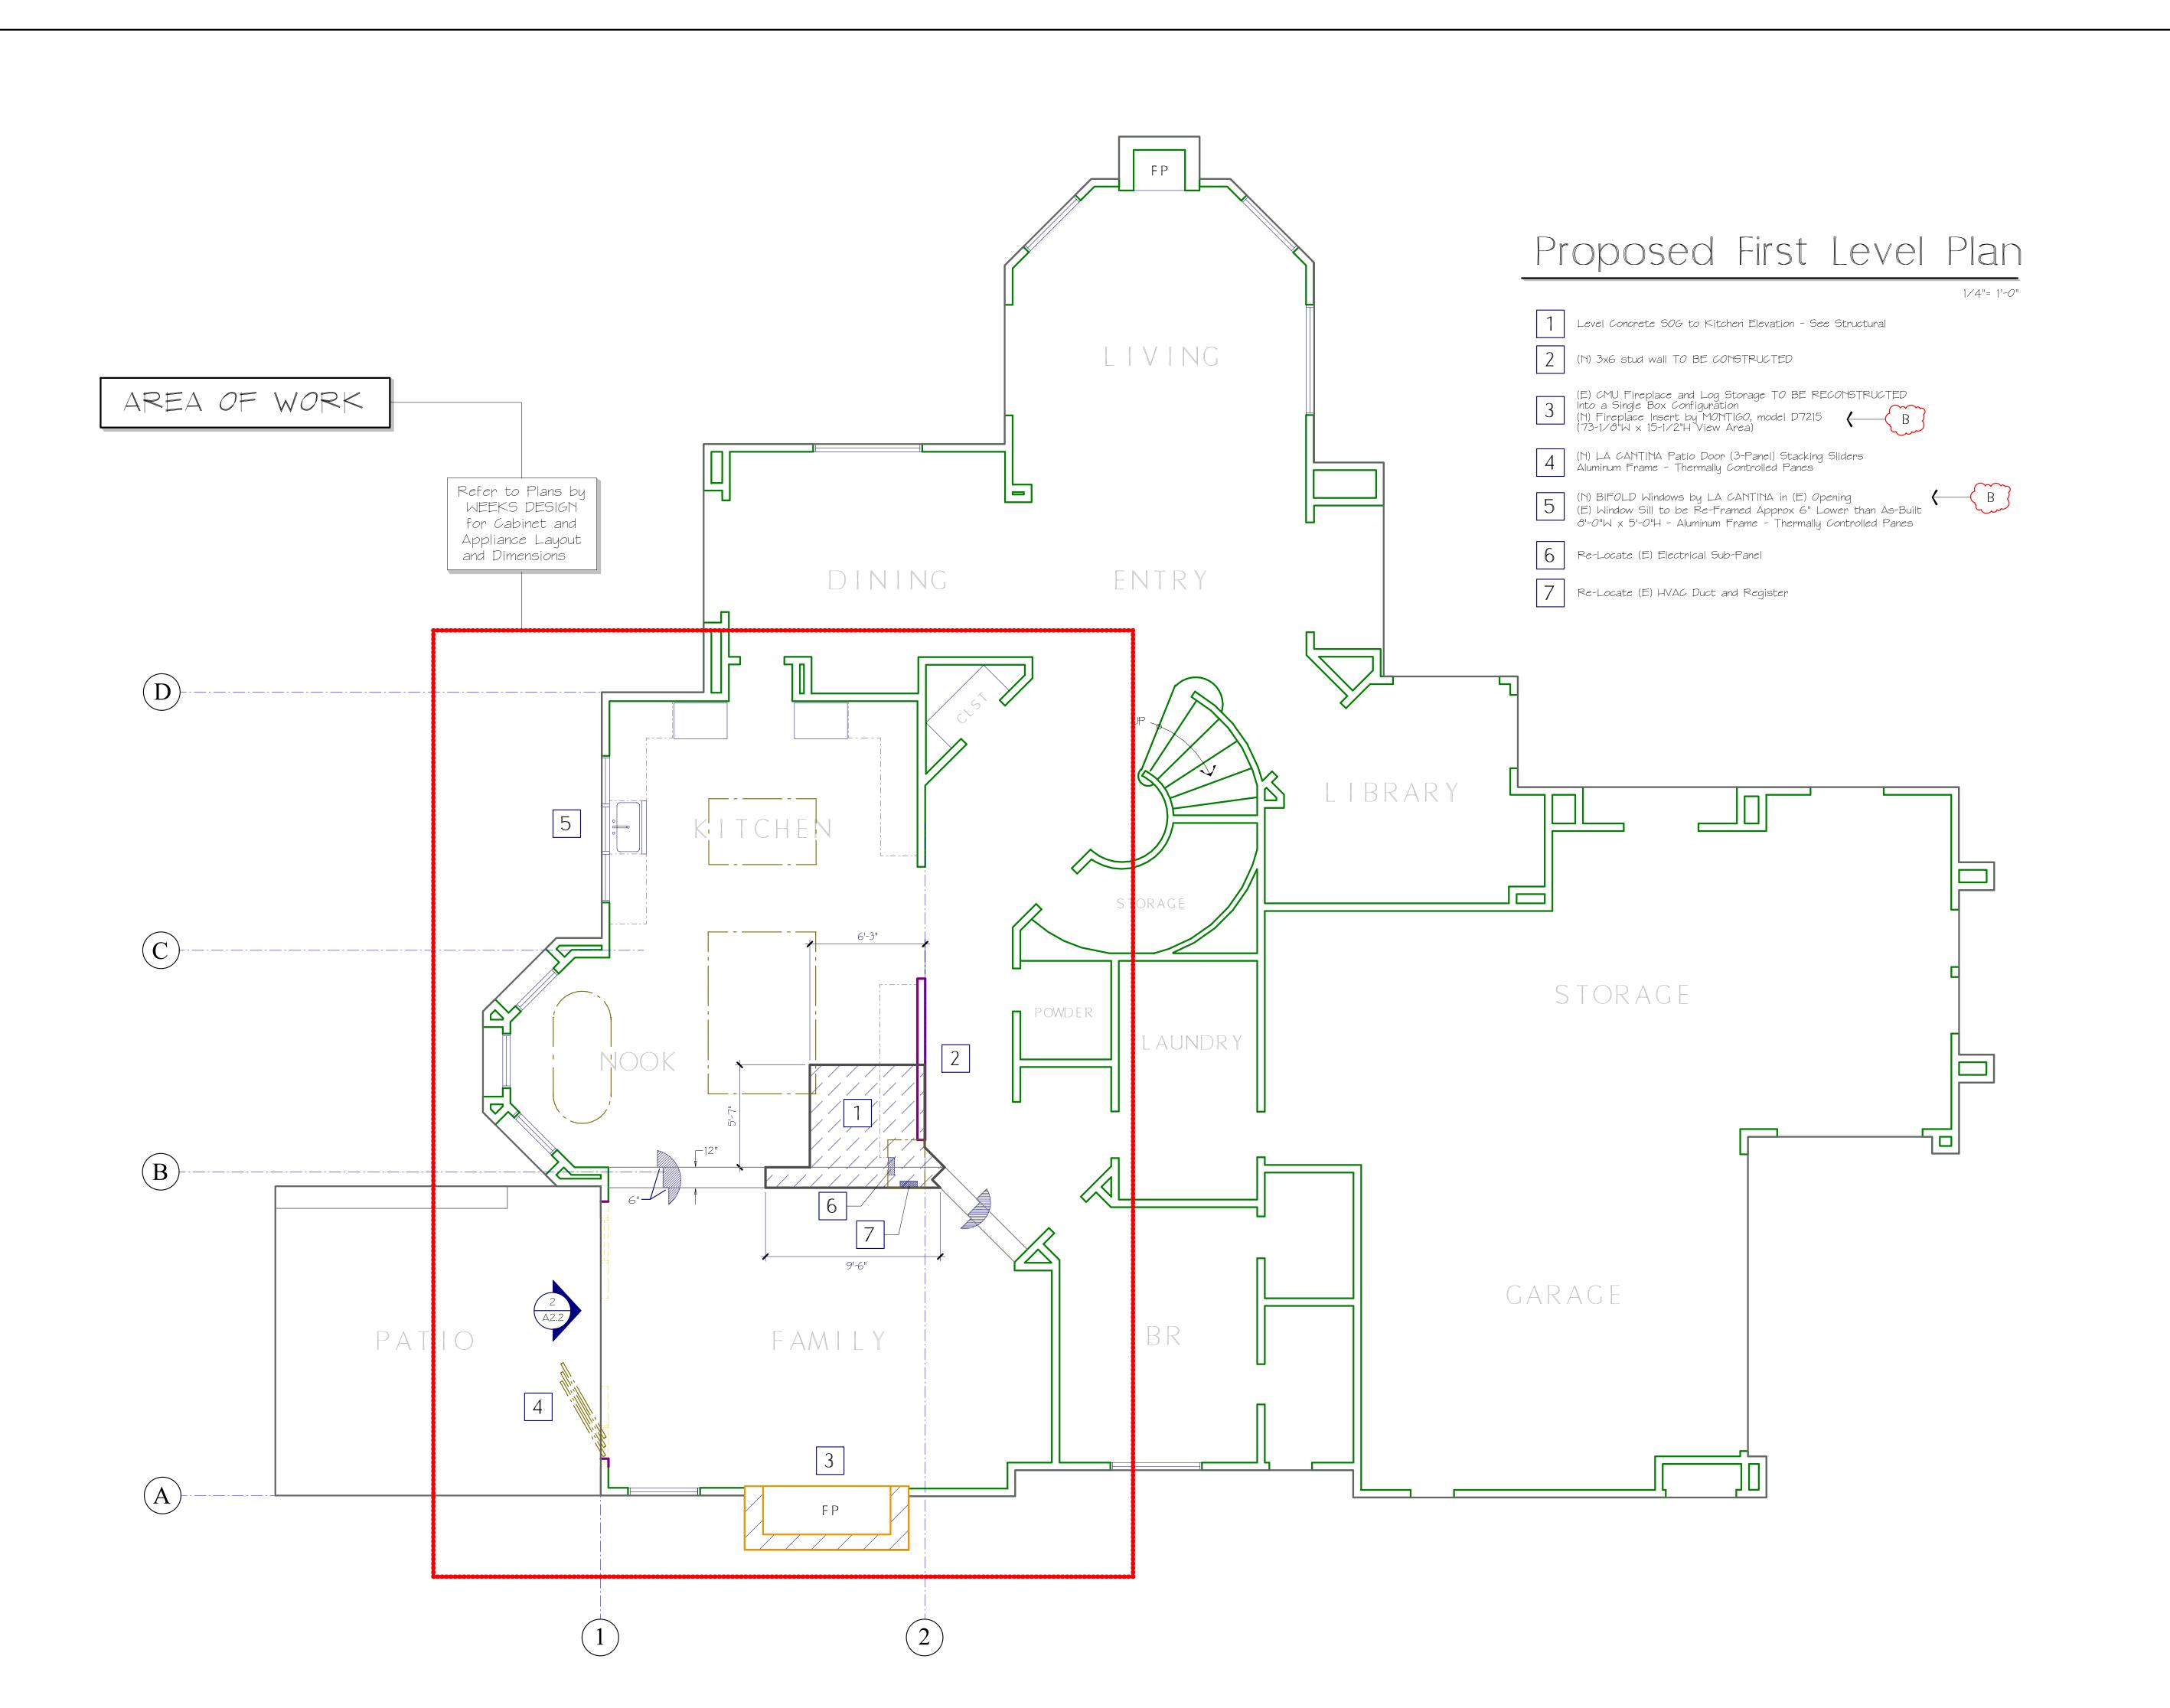

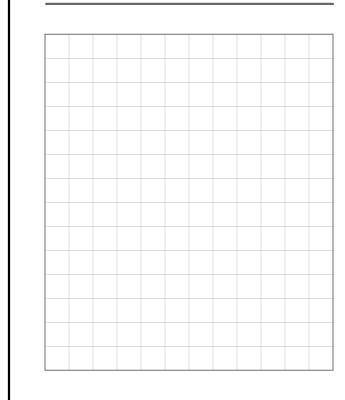

MK	DATE	DESCRIPTION
А	1/12/22	Building Dept Submittal
В 4	4/05/22	Plan Check Corrections
-+		




	BLUE WATER Project Number	21032
	Designer	SAB
	Engineer	ROZ
	Scale	as noted
l l		



LE WATE ENGINEERING CORP.

MK DATE	DESCRIPTION	
Δ 1/12/22	Building Dept Submittal	
B 4/05/22	Plan Check Corrections	

BLUE WATER Project Number	21 <i>0</i> 32
Designer	SAB
Engineer	R0Z
Scale	as noted

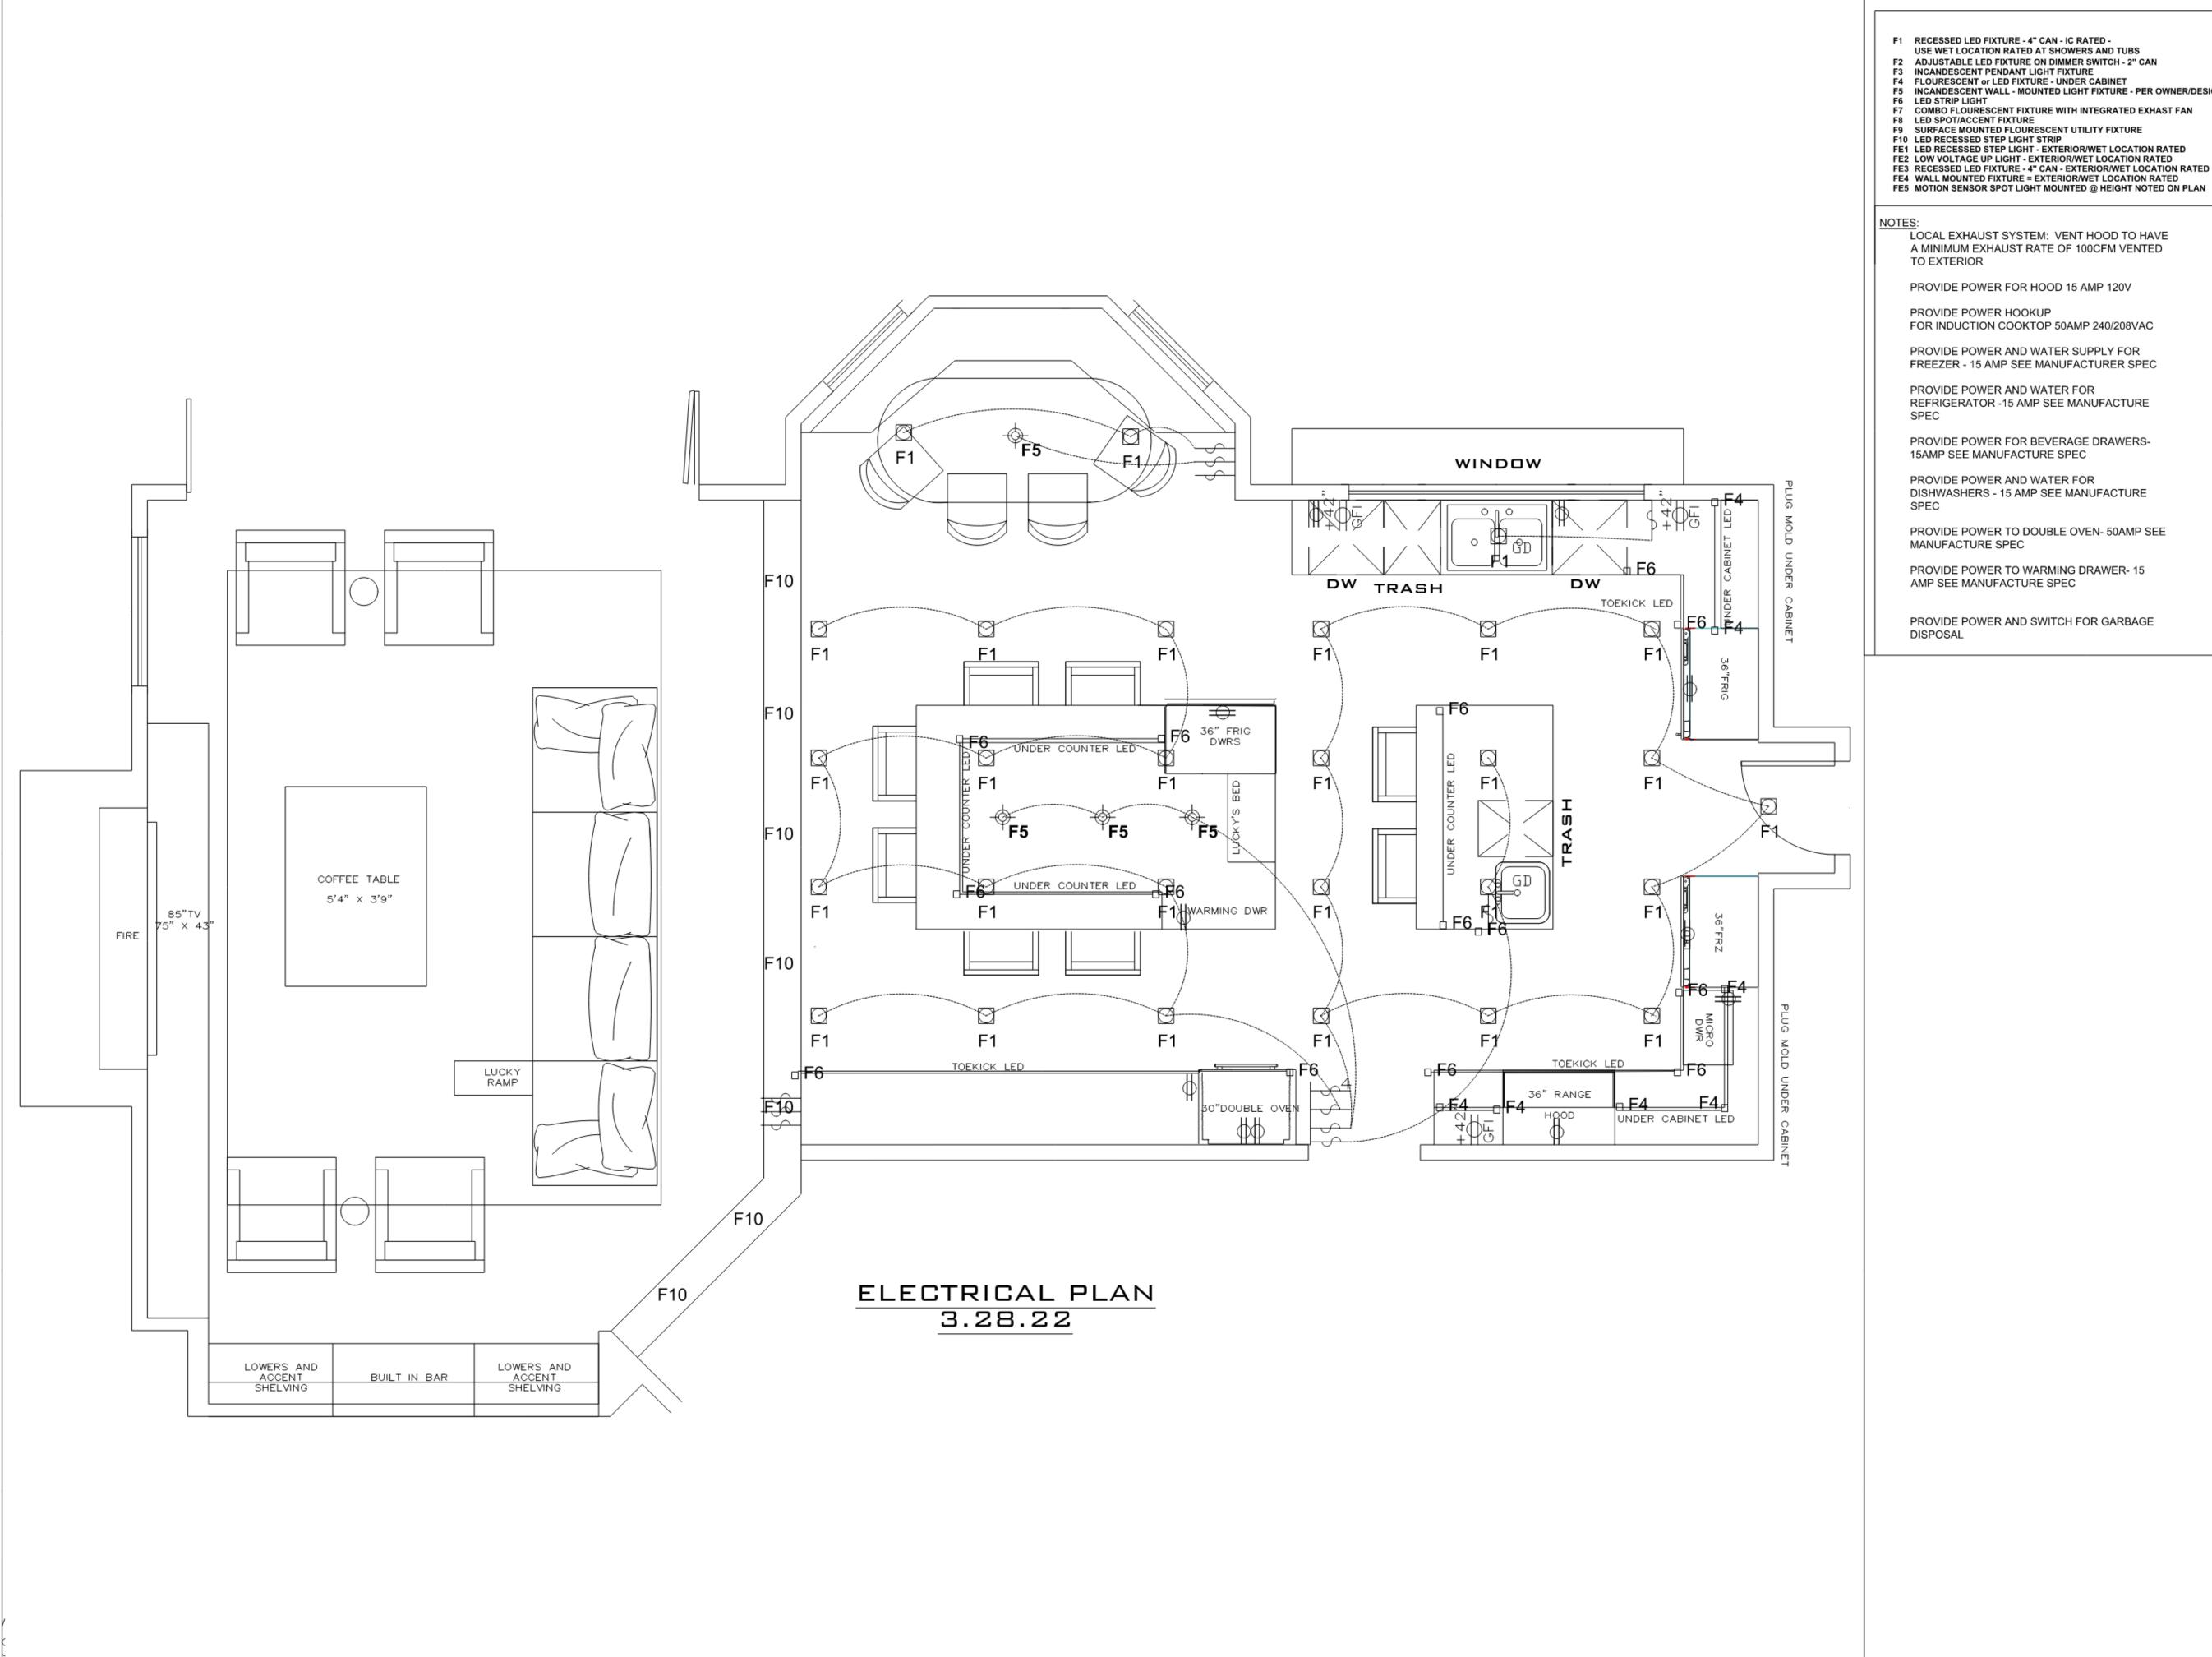

F1 RECESSED LED FIXTURE - 4" CAN - IC RATED -

USE WET LOCATION RATED AT SHOWERS AND TUBS

F2 ADJUSTABLE LED FIXTURE ON DIMMER SWITCH - 2" CAN
F3 INCANDESCENT PENDANT LIGHT FIXTURE
F4 FLOURESCENT or LED FIXTURE - UNDER CABINET
F5 INCANDESCENT WALL - MOUNTED LIGHT FIXTURE - PER OWNER/DESIGNER

F6 LED STRIP LIGHT
F7 COMBO FLOURESCENT FIXTURE WITH INTEGRATED EXHAST FAN
F8 LED SPOT/ACCENT FIXTURE
F9 SURFACE MOUNTED FLOURESCENT UTILITY FIXTURE

F10 LED RECESSED STEP LIGHT STRIP
FE1 LED RECESSED STEP LIGHT - EXTERIOR/WET LOCATION RATED

FE2 LOW VOLTAGE UP LIGHT - EXTERIOR/WET LOCATION RATED
FE3 RECESSED LED FIXTURE - 4" CAN - EXTERIOR/WET LOCATION RATED

LOCAL EXHAUST SYSTEM: VENT HOOD TO HAVE A MINIMUM EXHAUST RATE OF 100CFM VENTED

PROVIDE POWER FOR HOOD 15 AMP 120V

PROVIDE POWER HOOKUP

FOR INDUCTION COOKTOP 50AMP 240/208VAC

PROVIDE POWER AND WATER SUPPLY FOR FREEZER - 15 AMP SEE MANUFACTURER SPEC

15AMP SEE MANUFACTURE SPEC

PROVIDE POWER AND WATER FOR DISHWASHERS - 15 AMP SEE MANUFACTURE

PROVIDE POWER TO DOUBLE OVEN- 50AMP SEE MANUFACTURE SPEC

PROVIDE POWER TO WARMING DRAWER- 15 AMP SEE MANUFACTURE SPEC

PROVIDE POWER AND SWITCH FOR GARBAGE

ARCHITECTURAL BY:

DATE: **3.28.22**

SCALE:

1/2"=1'-0"

AREA:

ELECTRICAL

PAGE